



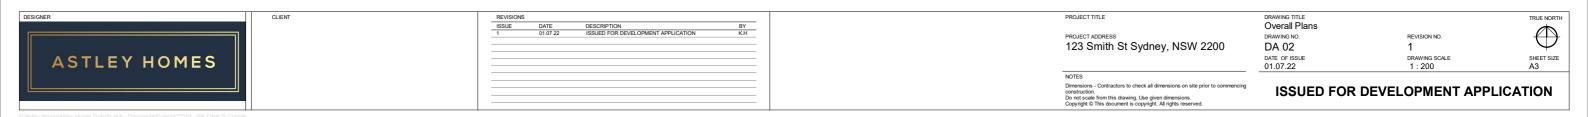

Overall Floor Plans

1:200



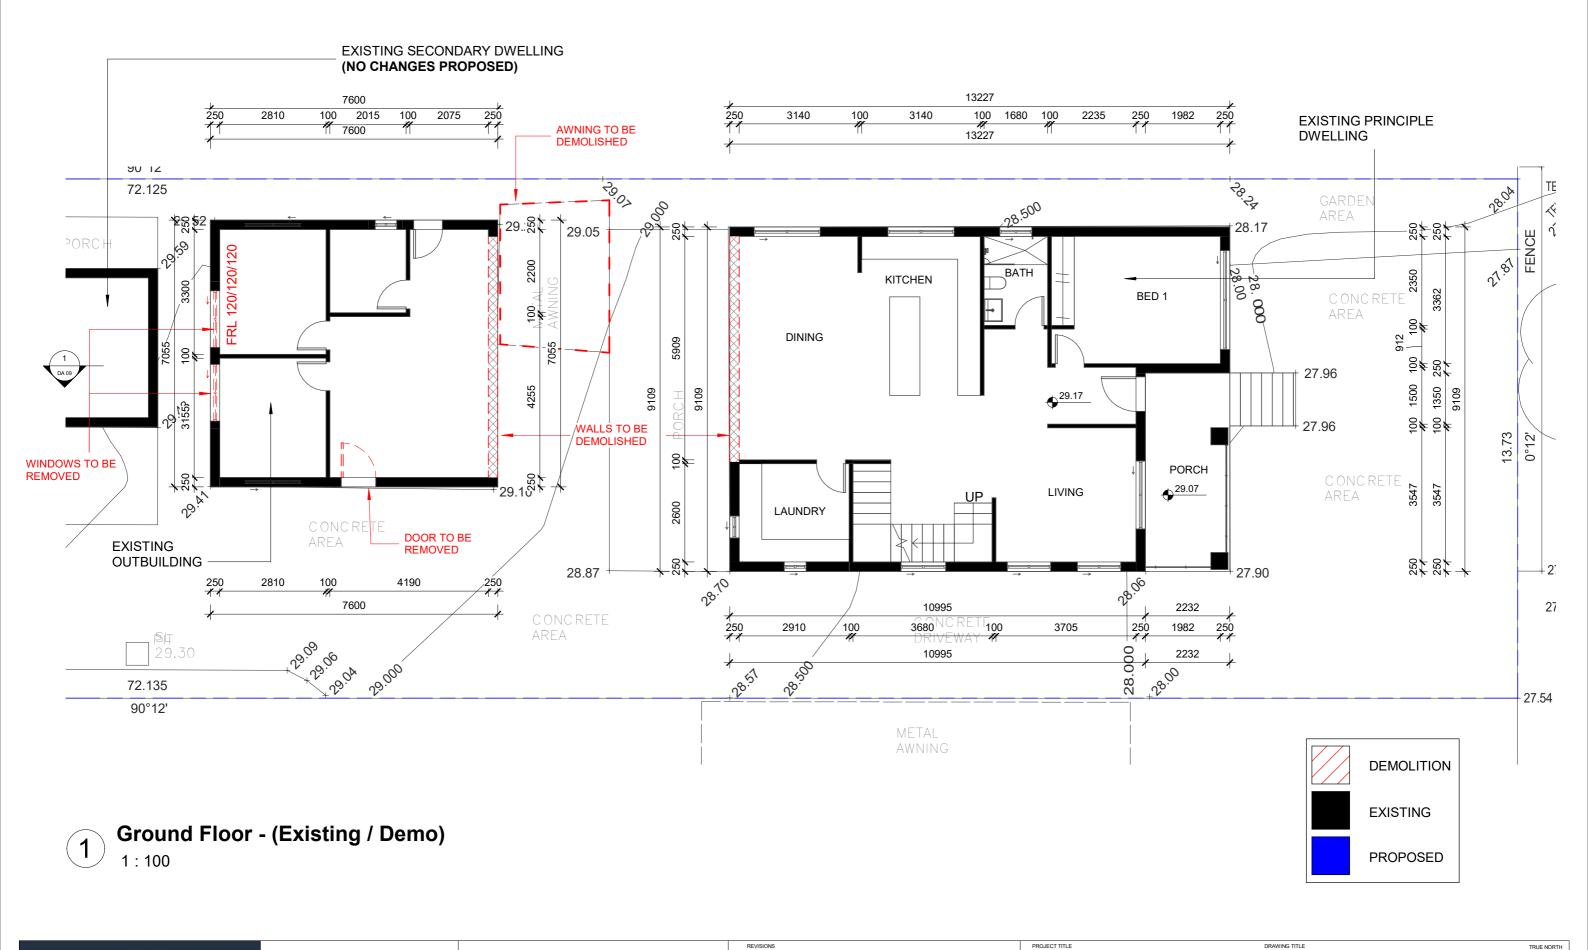






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ISSUE	DATE	DESCRIPTION	BY
1	01.07.22	ISSUED FOR DEVELOPMENT APPLICATION	KH

123 Smith St Sydney, NSW 2200

DRAWING TITLE
Existing Ground Floor Plan DA 03

REVISION NO. DRAWING SCALE
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BUILDING DESIGNER

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Proposed Ground Floor
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BUILDING DESIGNER

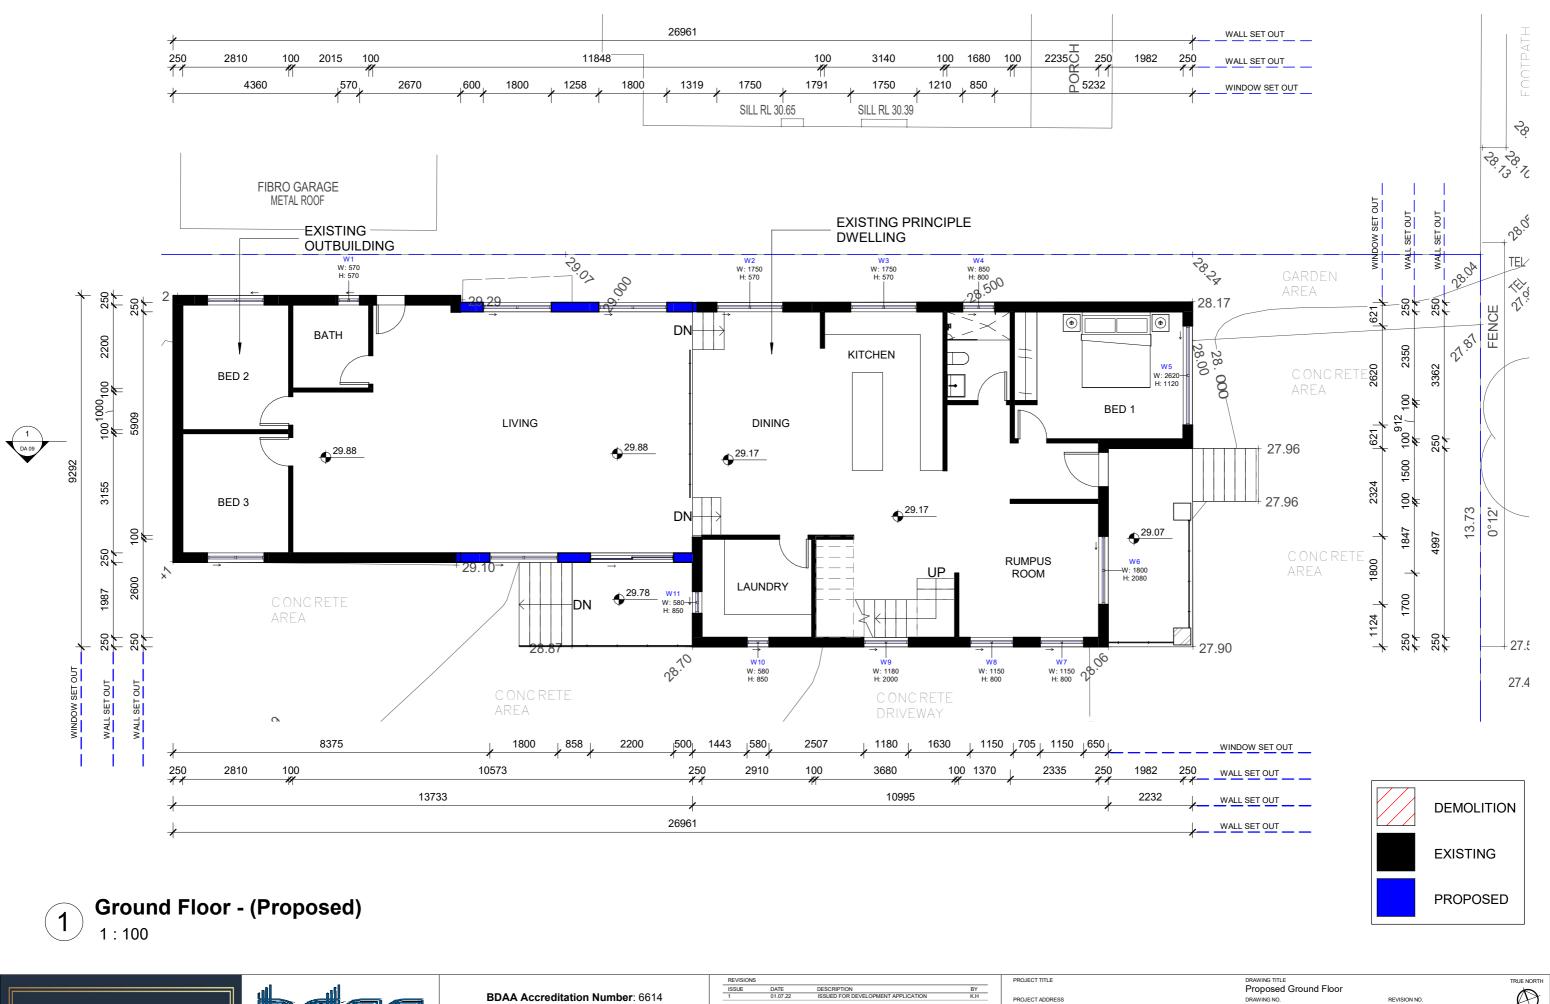BDAA Accreditation Number: 6614
Class 2 Registration Number: DEP0001004


Proposed Ground Floor
DRAWING NO.
DATE OF ISSUE
DRAWING SCALE
AS Indicated
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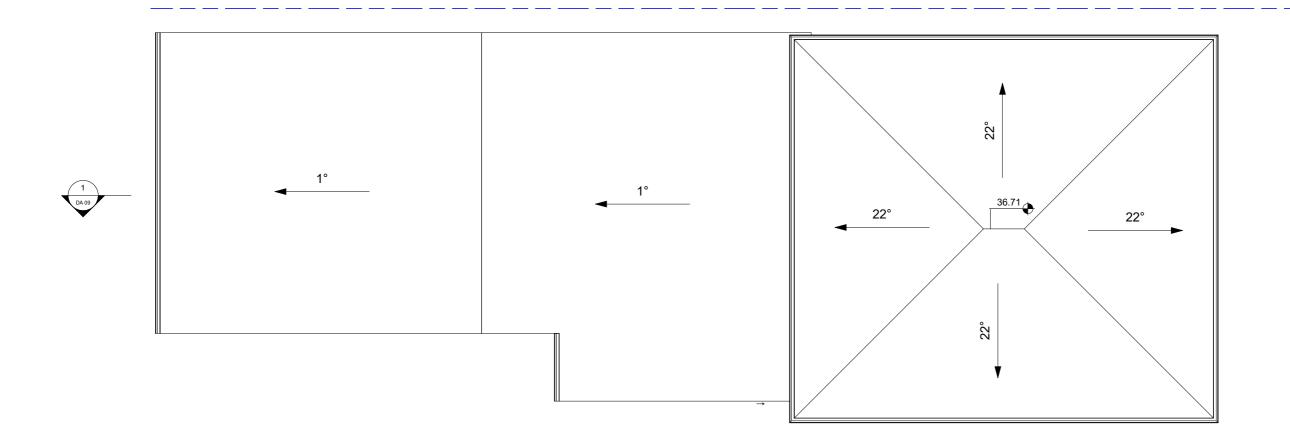
PROJECT ADDRESS 123 Smith St Sydney, NSW 2200 DRAWING TITLE
FIRST Floor Plan
DRAWING NO.
DA 05
DATE OF ISSUE
01.07.22

REVISION NO.

1
DRAWING SCALE
As indicated

TE OF ISSUE DRAWING SCALE SHEET SIZE 1.07.22 As indicated A3

ISSUED FOR DEVELOPMENT APPLICATION

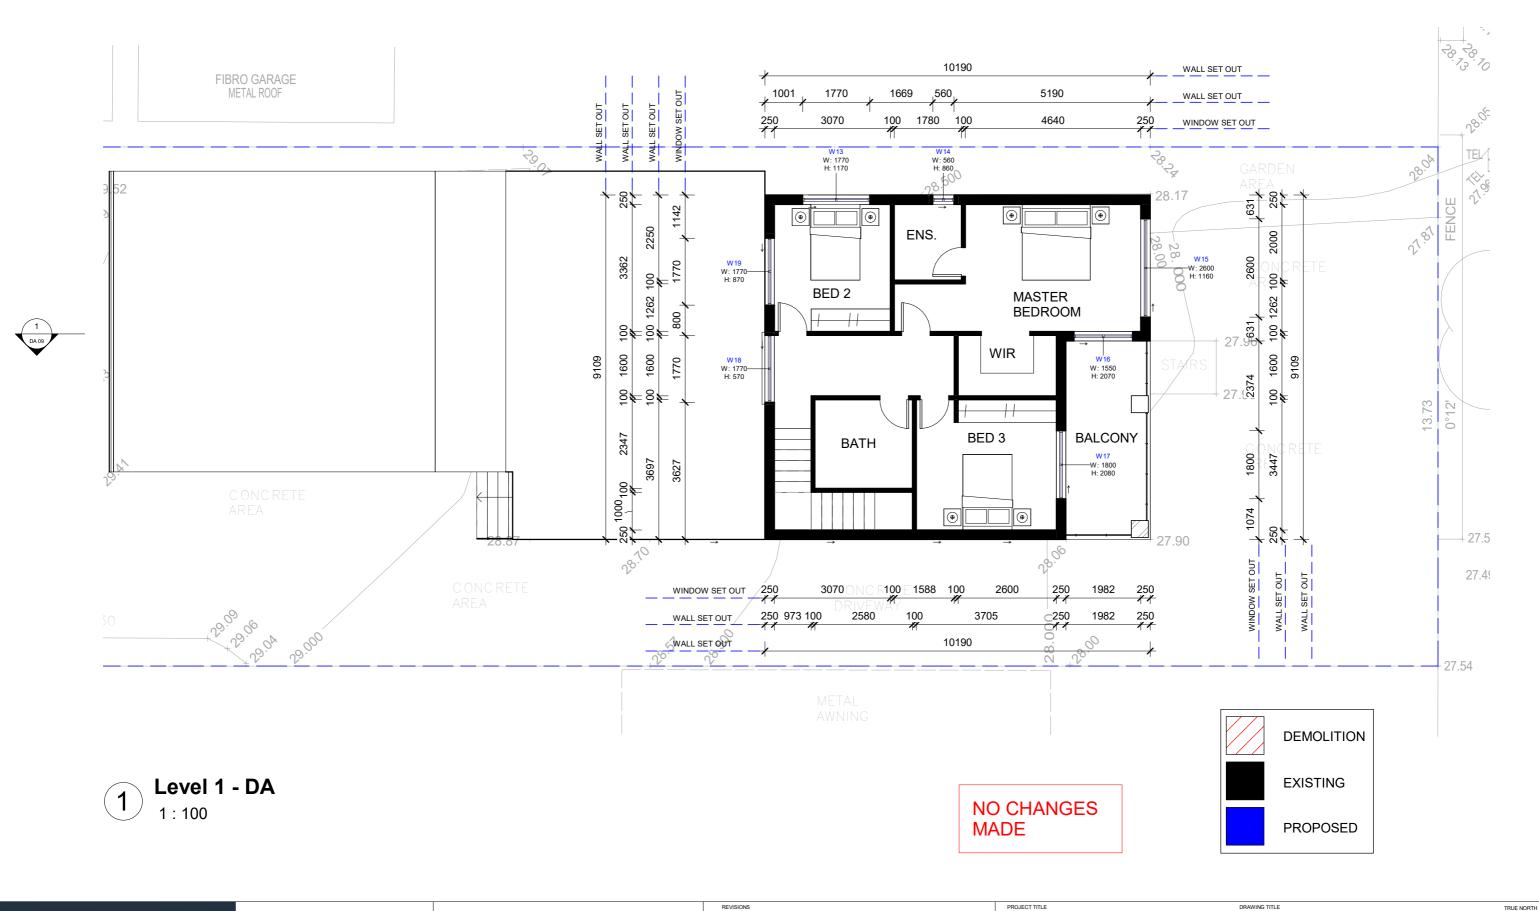

Roof Plan - DA1 : 100





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ROOf Plan
DRAWING NO.
DA 06
DATE OF ISSUE
01.07.22

TRUE NORTH


REVISION NO.

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DRAWING SCALE

1: 100

A3

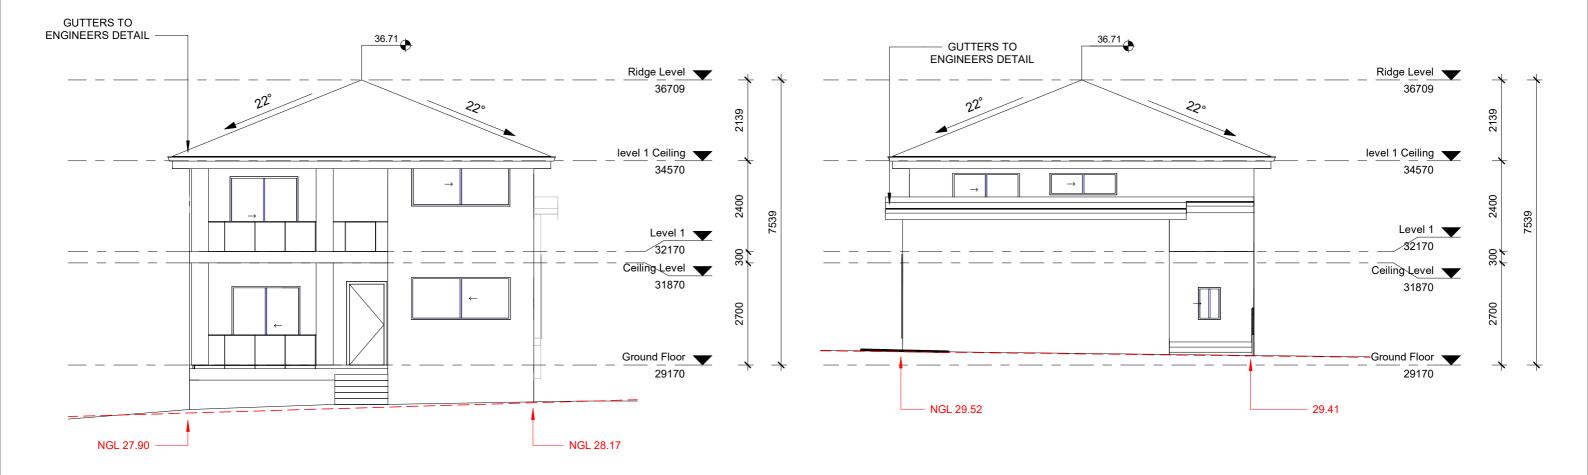

1

East Elevation

1:100

Lasi Lievai



West Elevation

1:100





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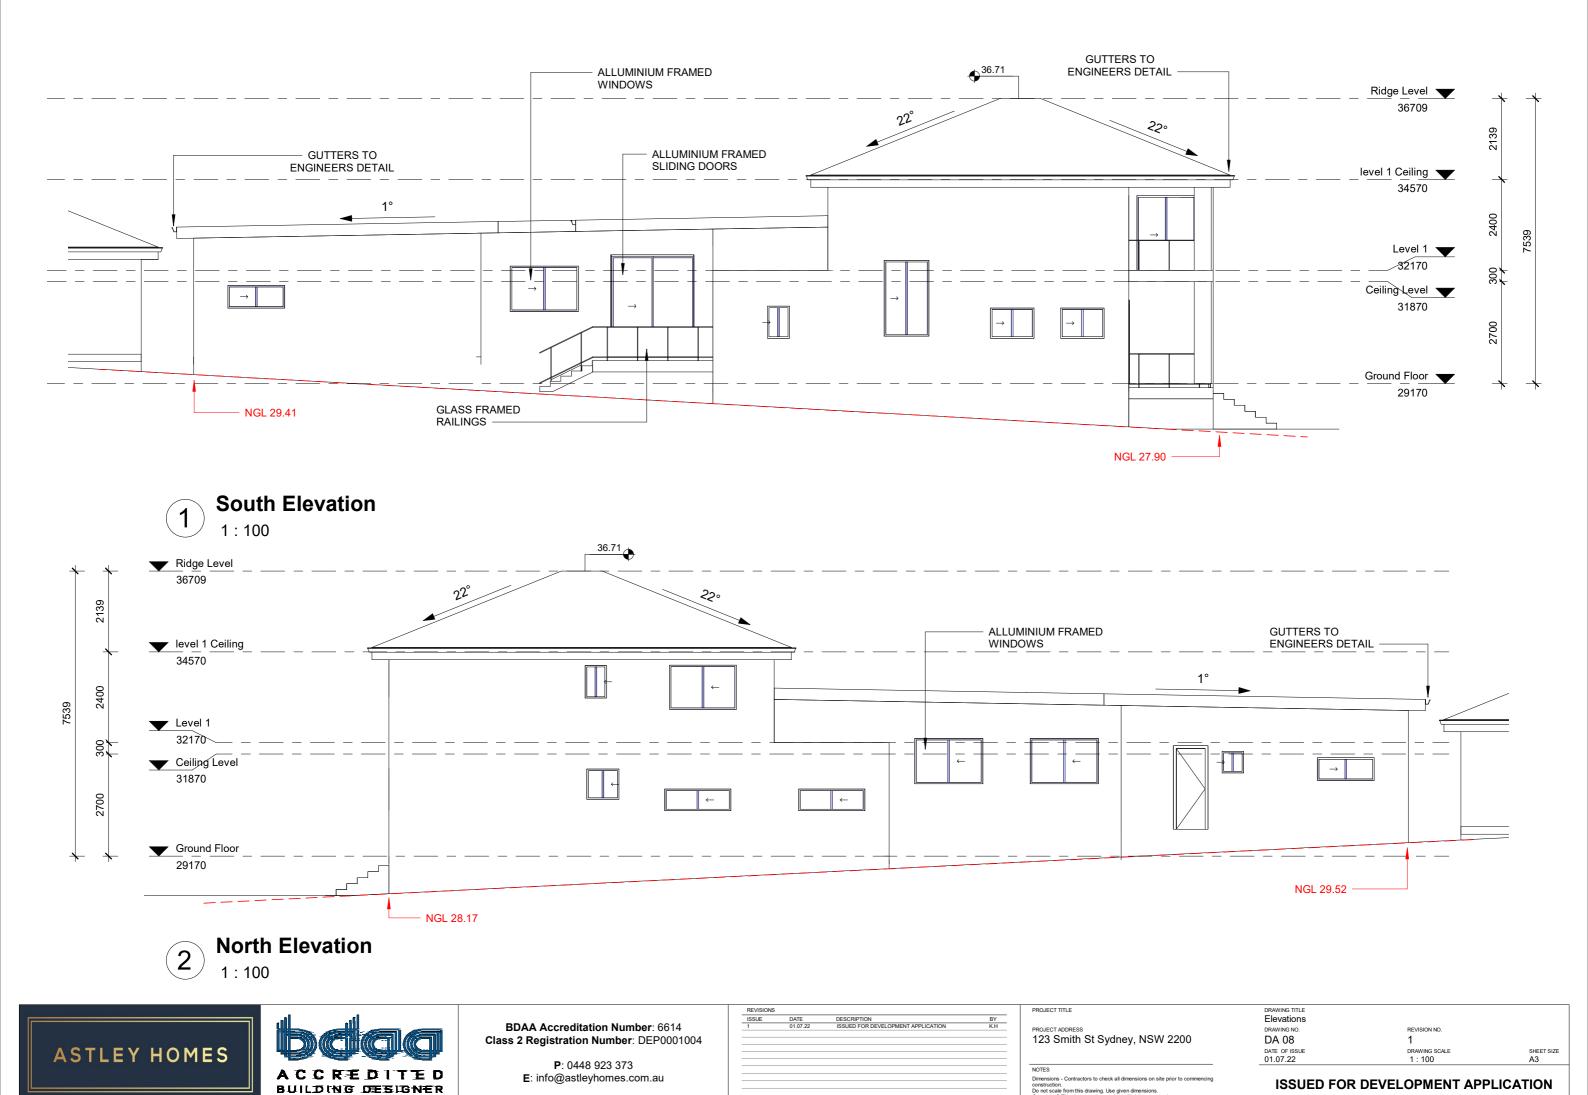
Elevations

DRAWING NO. REVISION NO.

DA 07 1

DATE OF ISSUE DRAWING SCALE SHEET SI.

01.07.22 1:100 A3





Section 1

1:100





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Sections

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1:100

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NOTES
Dimensions - Contractors to check all dimensions on site prior to commencing construction.
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DRAWING TITLE

FSR Calculations

DRAWING NO.

DA 10

DATE OF ISSUE

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REVISION NO.


REVISION NO.

DRAWING SCALE

SHEET SIZE


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A3



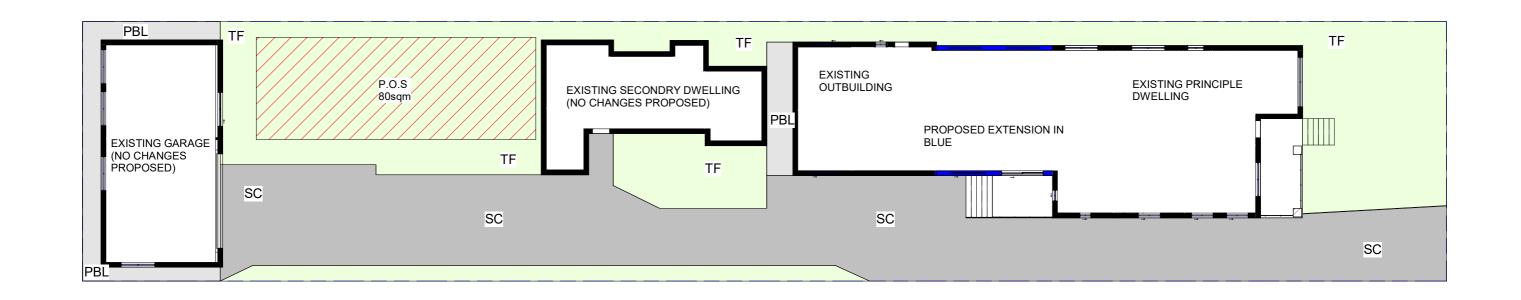



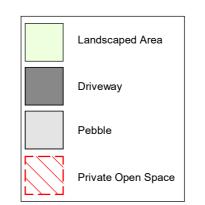

PLANT SCHEDULE

DSG

LM

MYO


Plant Name


Correa alba

Liriope muscari

Duranta 'Sheenas Gold'

Myoporum parvifolium Philodendron 'Xanadu'

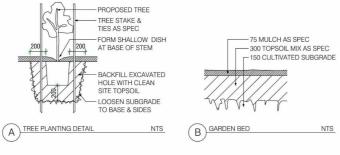

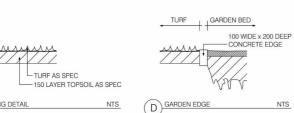

SURFACE TREATMENT LEGEND

STF Synthetic Turf

TF Turf

GE Garden Edge (to detail)

Clothes Lines (to client requirements)

Colorbond / Timber Paling (1.8 high) CB/TP

Tile (to client requirements)

RWT Rainwater Tank (to Engineers Specifications)

PV

Water Permeable Unit Paver

SC Stenciled Concrete (Charcoal/gunmetal)

DGR Decomposed Granite finish

TPF Temporary Protection Fence (1.8m chainmesh)

Mature Size

Trim to 0.6m

Trim to1.0m

0.5m

0.2m 0.5m

Qty

18No.

10No.

10No.

30No.

12No.

INo.

GVL Gravel Surface / Path (Nepean River Pebble)

TD Timber Deck

Concrete Path

Bench Seat

BT **Table Bench Seating**

Pot Size

200mm

100mm

150mm

200mm

NOTES AND SPECIFICATIONS

Prior to carrying out any excavations, the contractor is to confirm the locations of all services. Service pits and lids a not to be covered by any materials. Trim and grade area to form a smooth even finish.

GARDEN BED / MULCH

The topsoil to all garden bed areas shall be four (4) parts site topsoil to one (1) part organic compost thorough blended together prior to placing into position. Where the site topsoil is considered not suitable, an imported topso blend meeting the requirements of AS4419-1998 shall be used. Garden bed subgrades are to be cultivated to a depth-150mm. Topsoil depths to all garden bed areas in deep soil to be 300mm (min). At the completion of all planti operations apply a 75mm layer of mulch over entire garden bed taking care not to smother plants. Receive depth-mulch around base of plants to form "watering dish". Mulch used shall be Pine Bark Nuggets as supplied by ARI. similar. All proposed planting is subject to suitable topsoil depths on site. Where there is insufficient depth due presence of bedrock or other structures, the proposed planting is to be modified to suit in accordance with instruction from landescape architect.

TURF / GARDEN EDGING

PLANT MATERIAL

Turf used for this site shall be Sir Walter Buffalo or similar soft leaf variety. Unless specified otherwise, turf shall I laid over 150mm topsoil and finished flush with adjacent surfaces. Water turfed areas immediately after turfut operations. Topdress any excessively undulating areas to form a smooth level surface with a coarse grade washed riv sand. All garden edging as denoted by 'GE' on the plan is to be constructed as per detail.

The plants are to be healthy nursery stock, free from disease, injury, insects all weed or roots of weeds. All plants are be thoroughly soaked lhour prior to planting. All plants delivered for use on site shall be fully acclimatized prevailing local Sydney conditions.

EXISTING TREES TO BE RETAINED

The existing trees indicated for retention shall be protected for the duration of the construction period. Insta a 1.8m high temporary protective fence (TPF) to the locations as indicated on the plan. Do not store otherwise place bulk or harmful materials under or near a tree which is to be retained. Do not attach stay guys and the like to a tree which is to be retained. Where it is absolutely necessary to prune tree roots / liml contractor to ensure all Council approvals have been obtained. All tree work is to be carried out by a qualific and insured arborist. Where an arborist report has been prepared for the existing tree on site; The landscape plan shall be read in conjunction with this report. All trees identified for retention shall be protected and managed accordance recommendations of this report. These recommendations will take precedence over any measures outline the landscape plan. the landscape plan.

MAINTENANCE / ON GOING CARE

MAINTENANCE / ON GOING CARE
Maintain all landscape areas to ensure plant health and occupant safety for period of 12 months beginning from datepractical completion to the satisfaction of Council. Maintenance will include but is not limited to the followin
activities: Mowing and edging lawn areas, fertilizing all plant material, pruning, watering, replacing failed plantin
treating for pests and diseases, topping up of mulch areas and weeding garden beds as required. On completion of tl
initial 12 month period, all maintenance responsibilities shall be handed over to building management / property own
for on-going care. Note: All trees will require ongoing annual observation and maintenance by qualified arborist
ensure occupant safety, tree health and to avoid damage to surrounding structures and property.

DISCREPANCIES

Should there be any discrepancies on the drawings with existing site conditions; contractor is to notify the landscal architect prior to proceeding with the works





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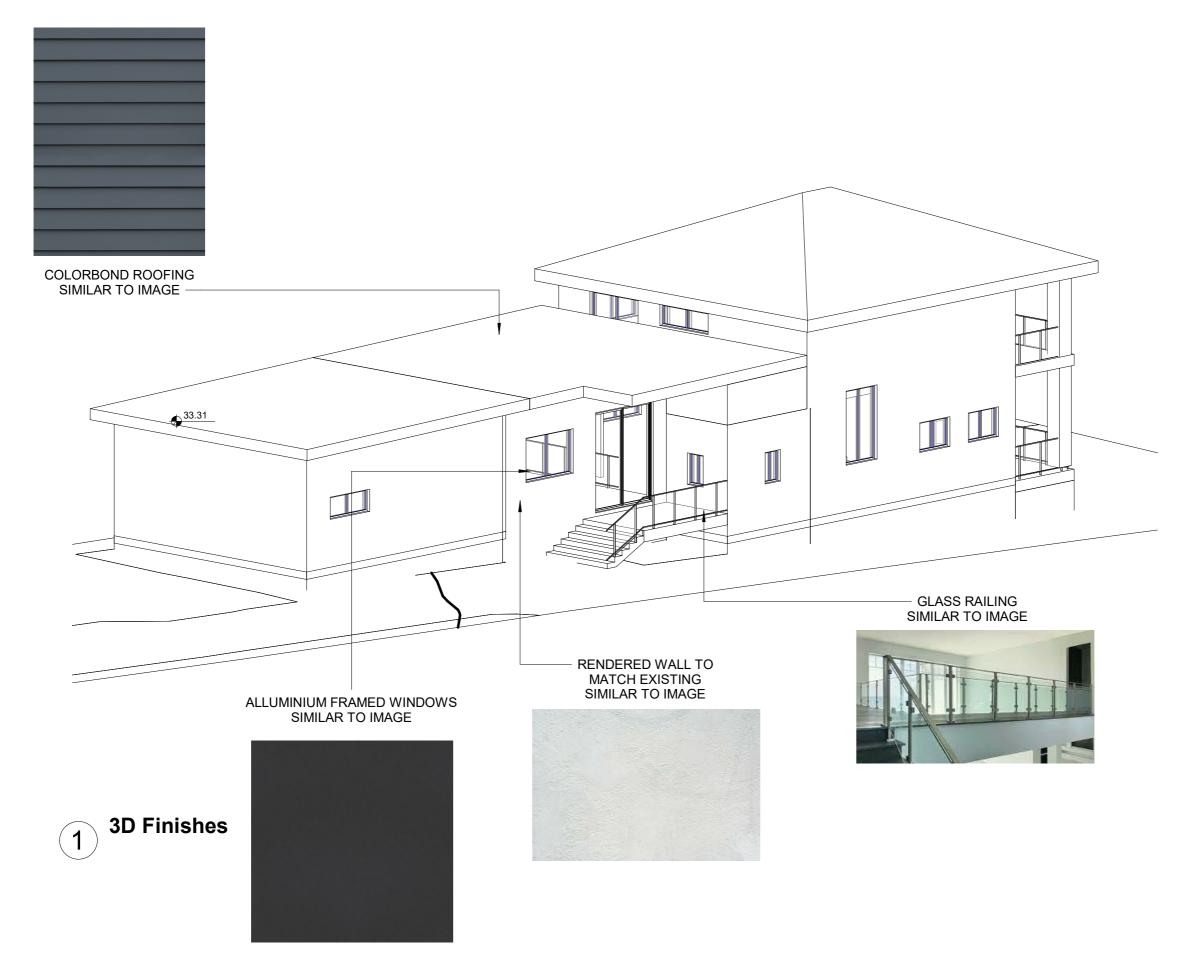
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Landscape Plan REVISION NO. DA 11 DRAWING SCALE
As indicated

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MOTES

DRAWING TITLE
Finishes Schedule
DRAWING NO.
DA 12

REVISION NO.

DA 12 1
DATE OF ISSUE DRAWING SCAL
01.07.22

Building Sustainability Index www.basix.nsw.gov.au

Alterations and Additions

Certificate number: A465384

This certificate confirms that the proposed development will meet the NSW government's requirements for sustainability, if it is built in accordance with the commitments set out below. Terms used in this certificate, or in the commitments, have the meaning given by the document entitled "BASIX Afterations and Additions Definitions" dated 06/10/2017, published by the Department. This document is

project

of

The applicant must install the windows, glazed doors and shading devices, in accordance with the specifications listed in the table below. Relevant overshadowing specifications must be satisfied for each window and glazed door.

Each window or glazed door with standard aluminium or limber frames and single clear or toned glass may either match the description, or, have a U-value and a Solar Heat Gain Coefficient (SHGC) no greater than that listed in the table below. Total system U-values and SHGCs must be calculated in accordance with National Fenestration Rating Council (NFRC) conditions. For projections described in millimetres, the leading edge of each eave, pergola, verandah, balcony or awning must be no more than 500 mm above the head of the window or glazed door and no more than 2400 mm above the sill.

Pergolas with fixed battens must have battens parallel to the window or glazed door above which they are situated, unless the pergola also shades a perpendicular window. The spacing between battens must not be more than 50 mm. Overshadowing buildings or vegetation must be of the height and distance from the centre and the base of the window and glazed door, as specified in the 'overshadowing' column in the table below.

 1.5
 870
 1770
 eave\verandah\pergola\balcony
 standard aluminium, single clear, (or U-value: 7.63, SHGC: 0.75)

 1.5
 870
 1770
 eave\verandah\pergola\balcony
 standard aluminium, single clear, (or U-value: 7.63, SHGC: 0.75)

 1.5
 870
 1770
 eave\verandah\pergola\balcony
 standard aluminium, single clear, (or U-value: 7.63, SHGC: 0.75)

eave/verandah/pergola/balcony >=450 mm standard aluminium, single clear, (or U-value: 7.63, SHGC: 0.75)

eave/verandah/pergola/balcony >=450 mm standard aluminium, single clear, (or U-value: 7.63, SHGC: 0.75) eave/verandah/pergola/balcony >=750 mm standard aluminium, single clear, (or U-value: 7.63, SHGC: 0.75)

The following requirements must also be satisfied in relation to each window and glazed door:

Windows and glazed doors glazing requirements
Window / door Orientation Area of Overshadowing Sha
no. | Glass | Height | Distance |
inc. | (m) | (m) |
(m2)

1.5 870 1770

Pergolas with polycarbonate roof or similar translucent material must have a shading coefficient of less than 0.35.

Section number

Dwelling type

Secretary
Date of issue: Monday, 04, July 2022
To be valid, this certificate must be lodged within 3 months of the date of issue.



BASIX Certificate number: A465384

298 Edgar St Condell Park

Separate dwelling house

Certificate Prepared by (please complete before submitting to Council or PCA)

Name / Company Name: Astley Homes ABN (if applicable): 90128616090

Plan type and number Deposited Plan 159803

Fixtures and systems	Show on DA Plans	Show on CC/CDC Plans & specs	ı
Lighting			
The applicant must ensure a minimum of 40% of new or altered light fixtures are fitted with fluorescent, compact fluorescent, or light-emitting-diode (LED) lamps.		~	

BASIX Certificate number: A465384		

page 2 / 6

Construction	Show on DA Plans	Show on CC/CDC Plans & specs	Certifier Check		
Insulation requirements					
the table below, except that a) additional	r altered construction (floor(s), walls, and ceilings/roo al insulation is not required where the area of new cor		~	~	~
is not required for parts of altered constr	ruction where insulation already exists.		-		
is not required for parts of altered construction	Additional insulation required (R-value)	Other specifications			
, , , , , , , , , , , , , , , , , , , ,		Other specifications	_		
Construction	Additional insulation required (R-value)	Other specifications	_		

BASIX Certificate number: A465384

In these commitments, "applicant" means the person carrying out the development. Commitments identified with a "v/" in the "Show on DA plans" column must be shown on the plans accompanying the development application for the proposed development (if a development application is to be lodged for the proposed development). Commitments identified with a "\rightary" in the "Show on CC/CDC plans & specs" column must be shown in the plans and specifications accompanying the application for a construction certificate / complying development certificate for the proposed development. Commitments identified with a "\sqrt{"}" in the "Certifier check" column must be certified by a certifying authority as having been fulfilled, before a final occupation certificate for the development may be issued.

Planning, Industry & Environment Building Sustainability Index www.basix.nsw.gov.au

ASTLEY HOMES



BDAA Accreditation Number: 6614 Class 2 Registration Number: DEP0001004

Planning, Industry & Environment


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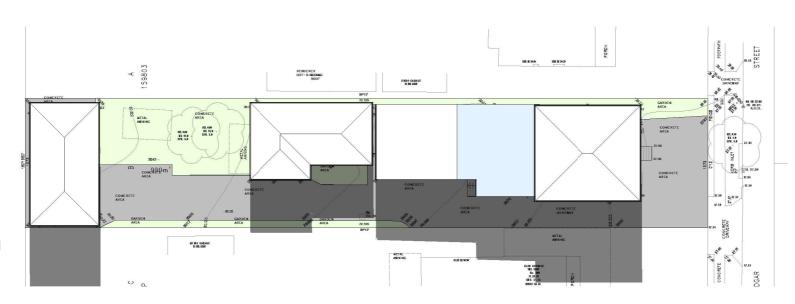
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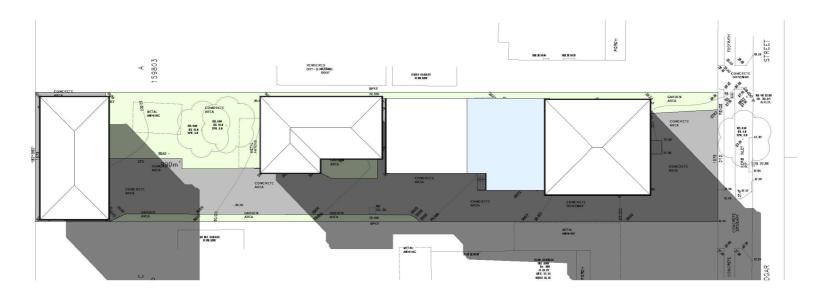
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21st June 9am 1:400



21st June 12pm 1:400



21st June 3pm 1:400

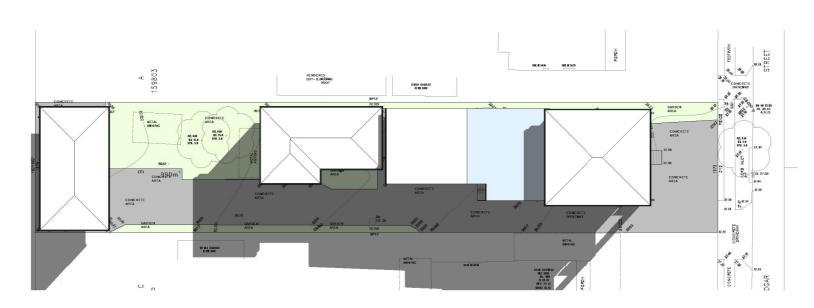



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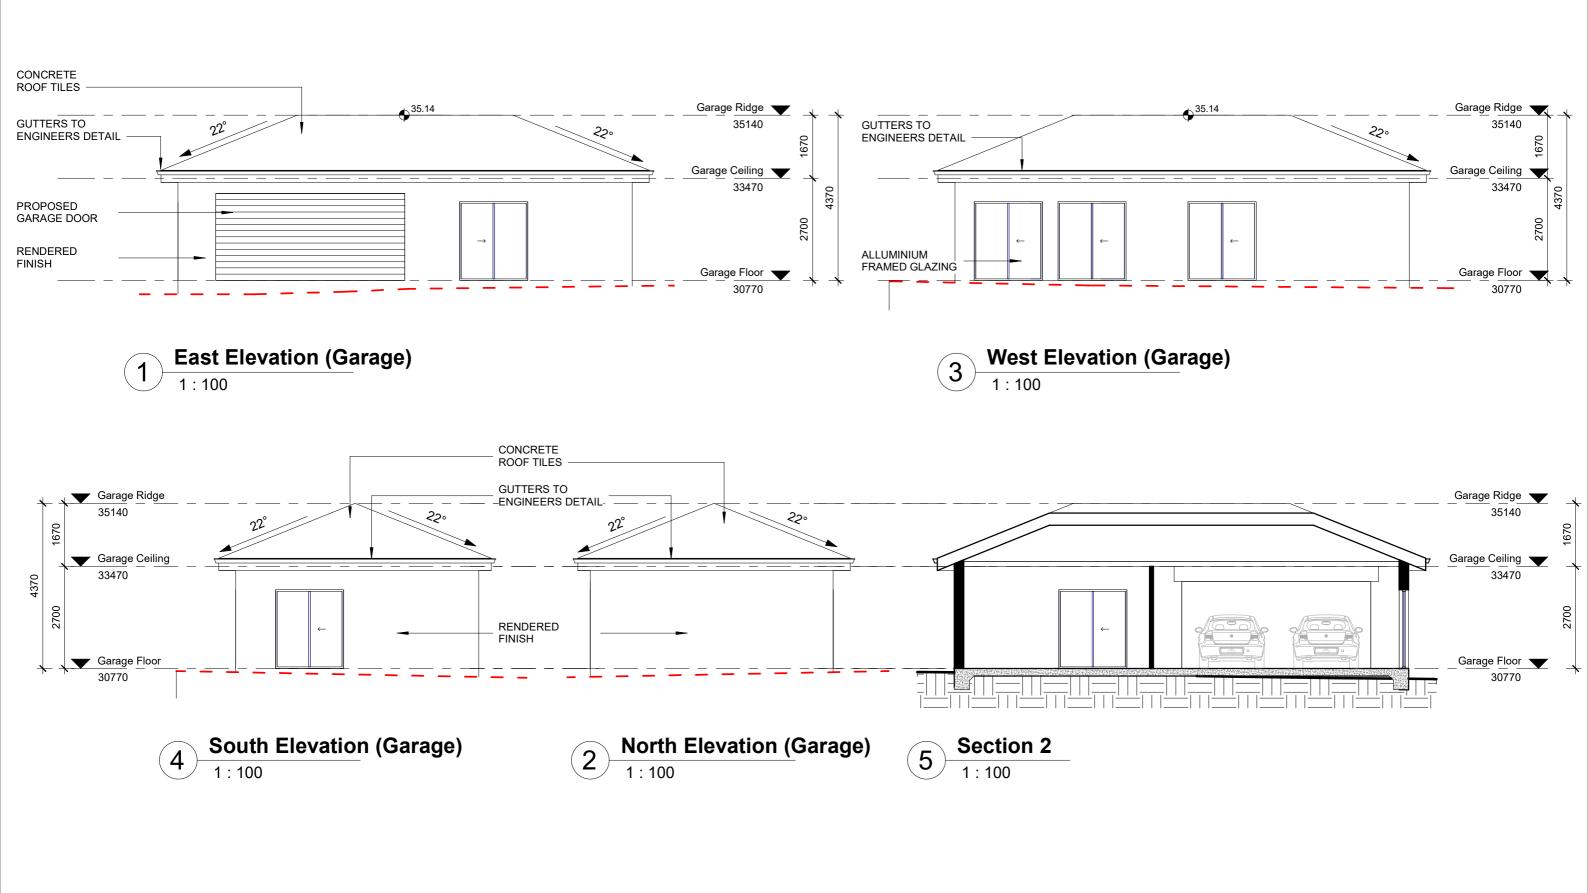
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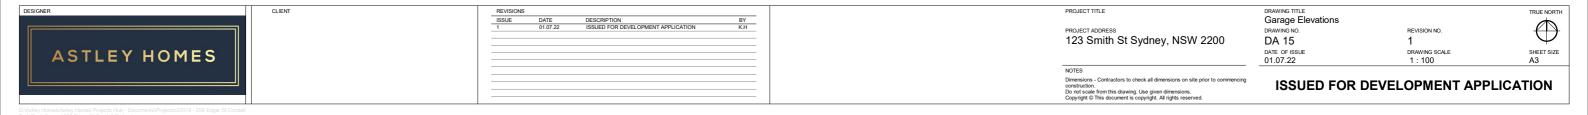
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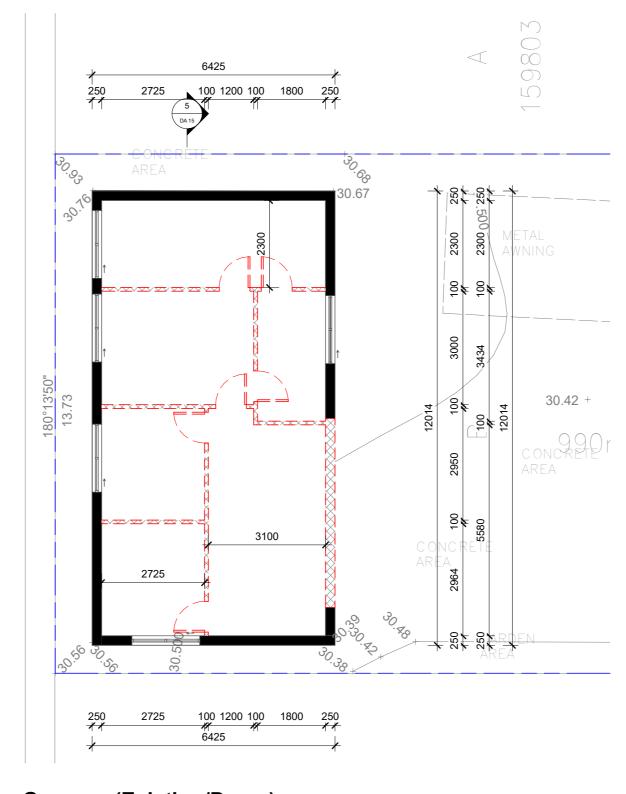
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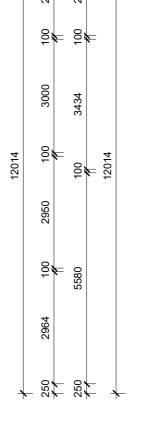
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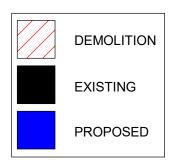






722 4

Garage - (Existing/Demo)





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DRAWING TITLE

Garage - Existing/demo

DRAWING NO.

DA 16


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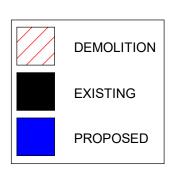
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Garage - Proposed

DRAWING NO.

DA 17

DATE OF ISSUE

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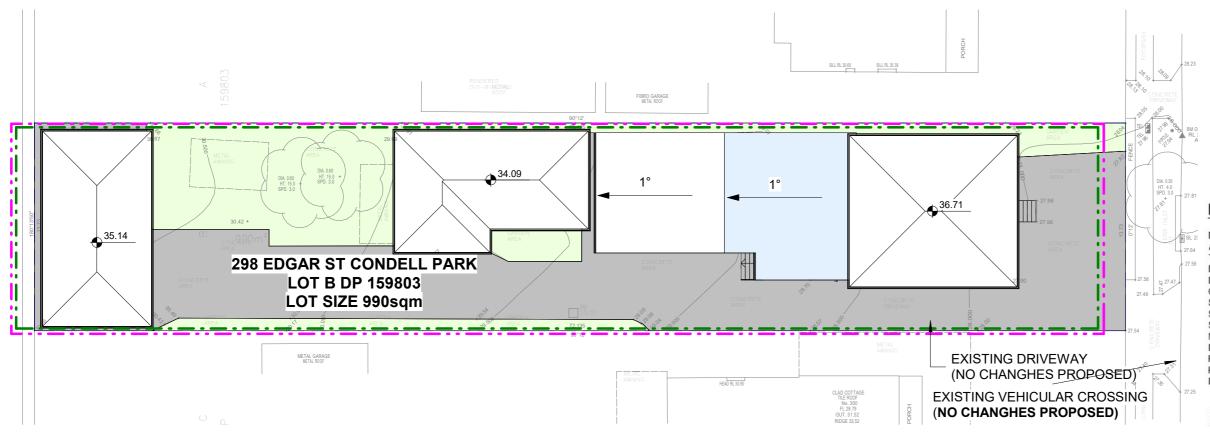
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As indicate

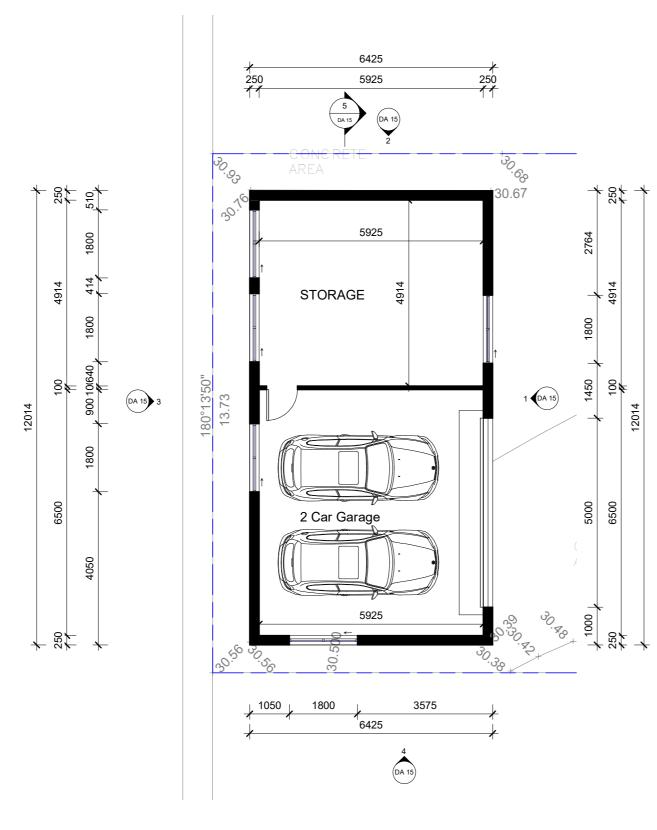T DRAWING SCALE As indicated

NOTES

Dimensions - Contractors to check all dimensions on site prior to commencing construction.



Sediment Control Plan

BUILDING MATERIAL STOCKPILES STEEL OR HARDWOOD POSTS CONSTRUCTION MANAGEMENT PLAN SANDBAG KERB INLET SEDIMENT TRAP WIRE STRAND ¥05k DEMOLITION PLAN AND SEDIMENT CONTROL MEASURES STEEL OR HARDWOOD POSTS 3 3m CENTRES ma: FILTER CLOTH WIRE STRAND **TEMPORARY FENCE** STAKE FILTER CLOTH INTO GROUND AT 600. CONSTRUCT 200×200 — DEEP TRENCH AND — LINE WITH FILTER CLOTH AND BACKFILL SEDIMENT FENCE RUN OFF FROM PAD DIRECTED TO SEDIMENT TEMPORARY CONSTRUCTION EXIT

DUST SUPRESSION MEASURES/ DEMOLITION:

DEMOLITION WORK TO BE CARRIED OUT IN ACCORDANCE WITH AS 2601-2001 ALL SAFTEY BARRIERS AND PROTECTIVE MEASURES ARE TO BE INSTALLED PRIOR TO THE COMMENCMENT OF WORKS

DEMOLITION WORKS TO BE CARRIED OUT IN ACCORDANCE WITH COUNCIL APPROVAL DEMOLITION CONTRACTORS TO PROVIDE EVIDENCE OF ALL INSURANCES PRIOR TO THE COMMENCMENT OF WORK

SAFTEY AND PROTECTIVE EQUIPMENT TO BE USED IN ACCORDANCE WITH RELEVANT STATUTORY REQUIREMENTS, IT IS THE CONTRACTORS RESPONSIBILITY TO ENSURE

MATERIAL TO BE REMOVED BY WAY OF WASTE BINS FROM SITE AND APPROPRIALEY DISPOSED OF IN WASTE RECYCLING FASCILITIES AND OR WASTE MANAGEMENT

PLACE GEOTECH FABRIC ALONG BOUNDARIES WHERE STRUCTURES ARE TO BE DEMOLISHED IN ORDER TO PROTECT ADJOINING PROPERTIES AND THE PUBLIC

SILT FENCES

- FILTERS SILT FROM LOW TO MEDIUM FLOWS OF SURFACE WATER ON GENTLY SLOPING OR STEEP UNEVEN TERRAIN.
- CONSIST OF A FILTER FABRIC ('GEOTEXTILE FILLER'), ATTATCHED TO A

STEEL WIRE OR CABLE, WHICH IS SUPPORTED ON 900mm LONG

STEEL OR WOODEN POSTS AT 2.5-3m CENTRES .

- THE LOWER END OF THE FABRIC IS EMBEDDED INTO THE GROUND , AS
- GENERALLY FOLLOW THE CONTOURS OF THE LAND .

EROSION CONTROL NOTES:

- 1. ALL ERSION AND SEDIMENT CONTROL MEASURES TO BE INSTALLED PRIOR TO SITE DISTURBANCE AND TO BE INSPECTED AND MAINTAINED DAILY BY
- 2. STRIPPING OF GRASS AND VEGETATION ETC. SITE MANAGER. FROM SITE SHALL BE KEPT TO A MINIMUM. 3. TOPSOIL FROM ALL AREAS THAT WILL BE DISTURBED TO BE STRIPPED AND STOCKPILED AND TO BE KEPT CLEAR FROM DRAINS, GUTTERS
- 4. DRAINAGE IS TO BE CONNECTED TO STORMWATER AND FOOTPATHS.
- SYSTEM AS SOON AS POSSIBLE.
- 5. ROADS AND FOOTPATH TO BE SWEPT DAILY
- 6. ALL SEDIMENT CONTROL STRUCTURES TO BE INSPECTED AFTER EACH RAINFALL EVENT FOR STRUCTURAL

DAMAGE AND ALL TRAPPED SEDIMENT TO BE REMOVED TO A NOMINATED SOIL STOCKPILE.

SILTATION MANAGEMENT PROCEDURE

- 1. ERECT SILT FENCE & GRAVEL DRAIN
- 2. DEMOLISH EXISTING BUILDING
- 3. EXCAVATE BASEMENT AND PLACE TEMPORARY PUMPOUT SEDIMENT PIT
- 5 SILT FENCE AND GRAVEL DRAIN ARE NOT TO BE REMOVED UNTIL CONSTRUCTION IS COMPLETE AND GARDEN HAS BEEN FULLY RE-VEGETATED.





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DRAWING TITLE
Sediment Control Plan DA 18

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